COUNTY OF IMPERIAL

NILAND COUNTY SANITATION DISTRICT WASTEWATER TREATMENT PLANT AND COLLECTION SYSTEM IMPROVEMENTS

FEBRUARY 14th, 2024

ADDENDUM NO. 4

The bidders are advised that the Contract Documents and Specifications for the above-referenced project are hereby amended per the statements in this Addendum.

- 1. For clarification purposes, the Project Description included on Page 1 of 50 of the Improvement Plans issued with Addendum Number 2 and dated October 18th, 2023 is abbreviated. The Project Description included in the Special Conditions Section 1, Volume 2 of 5 issued with Addendum 2 and dated January 18, 2024 offers a Project Description with a comprehensive narrative and complete listing of the major work items associated with the wastewater treatment plant, evaporation/infiltration ponds and collection system improvements.
- 2. Construction Water for the project can be obtained along the IID "R" Lateral at a location determined by the Imperial Irrigation District. Arrangements for purchasing construction water can be made by contacting the Imperial Irrigation District (IID) Office located at 5364 Hovley Road, Brawley, California 92227 at phone number (760) 482-9900; contact person Kirk Hale. The IID construction water cost is \$425.00 for the first 5 acre foot of water and \$85.00 per acre foot of water thereafter. There is a \$250 non-refundable Encroachment Permit Fee which must be filed at the IID Real Estate Department at 1699 West Main Street, Suite F, El Centro, California 92243 at phone number (760) 339-9381; contact Patty Casius. The Encroachment Permit must be filed at the IID Real Estate Department prior to requesting construction water from the IID Office at 5364 Hovley Road, Brawley, California 92227. A "temporary application for water" form will be required to be prepared at the IID Office at 5364 Hovley Road, Brawley California 92227. The Contactor shall be required to provide all pumps, upstream and downstream piping, meters and install and place the pump and water conveyance system at the project site in accordance with IID requirements.
- 3. Chemical Piping illustrated on the plans shall conform to the requirements of Chemical Piping Technical Specification Section 15707. Chemical piping injection tubing shall conform to Technical Specification Section 15707.2.03.B. Piping illustrated on the plans is intended to define the general layout, configuration, routing and required method of support, pipe size and type only. It is the responsibility of the Contractor to provide a complete system in accordance with the plans and Technical Specifications. Per Technical Specification Section 15707.2.03.D, "Chemical piping bends shall not exceed 45

degrees". Per Technical Specification Section 15707.2.03.E, "At all exposed changes in direction in chemical piping, elbows shall be provided with extra threaded openings plugged to facilitate cleaning." 2 inch schedule 80 pvc carrier pipelines passing through concrete walls or floors shall be installed through 316 stainless steel sleeves installed before concrete is placed. Contractor shall forward all required submittal information for review and approval by the Engineer in accordance with Technical Specification Section 15707.1.04

- 4. The Evaporation/Infiltration Pond Pump Station Control Panel "called out" by construction keynote 45 on plan sheet 24 shall be provided with an exterior mounted air conditioning unit. The air conditioning unit shall be equipped with a thermostat to maintain the temperature within the Pump Station Control Panel at no greater than 85 degrees Fahrenheit. Install all required electrical circuitry, transformers, breakers, etc. for the Pump Station Control Panel A.C. unit. Submittal information regarding the A.C unit is to be forwarded with the Pump Station Control Panel for review and approval by the Engineer.
- 5. Improvement plans 1 through 8 dated October 18, 2023, issued with Addendum Number 2 were revised to address State of California Department of Transportation Encroachment Permit review comments and are no longer valid. Improvement plans 1 through 8 dated October 18, 2023 are hereby replaced with Improvement plans 1 through 8 dated February 7, 2024 with a Title Sheet stamped "Addendum #4".
- 6. Questions forwarded regarding the Shade Structures for the Potable Water System, Sodium Hypochlorite Facility and Sodium Metabisulfite Facility were answered as follows:
 - 6.1 Question: Can you please confirm we have three (3) shade structures?
 - 6.1 Answer: Yes, there are three (3) shade structures.
 - 6.1.1 See Detail H and Section E-E on plan sheet 5 of 50.
 - 6.1.2 See new 4,350-gallon Sodium Hypochlorite Tank Blow-up Plan on plan sheet 9 of 50 and new 4,350-gallon Sodium Hypochlorite Structure Cross-Section K-K on plan sheet 10 of 50.
 - 6.1.3 See new 2,500-gallon Sodium Metabisulfite Tank Blow-up Plan on plan sheet 9 of 50 and new 2,500-gallon Sodium Metabisulfite Structure Cross Section L-L on plan sheet 10 of 50.
 - 6.2 Question: Can you please confirm the dimensions: 30' x 24' x 12' along with 24' x 36' x 12' and finally 20' x 32' x 12'?
 - 6.2 Answer: Yes, the dimensions are correct; Potable Water System shade structure is 30' x 24' x 12' per plan sheet 5 of 50; Sodium Hypochlorite shade structure is 24' x 36' x 12' per plan sheet 9 of 50; and Sodium Metabisulfite shade structure is 20' x 32' x 12' per plan sheet 9 of 50. The length and width dimensions are measured from center of support column to center of support column.
 - 6.3 Question: When I looked on the written specification ... I didn't see any hot dipped galvanized steel nor did I see stainless steel hardware included. The structure will rust/corrode rather quickly unless the steel is treated and the

hardware is stainless steel. Is it safe to assume that when I submit my proposal to the General Contractors?

6.3 Answer

Sections E-E, L-L and K-K on plan sheets 5 and 10 of 50 state, "Shade structure shall be constructed with hot-dip galvanization (HDG) steel and stainless steel hardware."

END OF ADDENDUM NO. 4

Prepared by: John Gay, P.E. Public Works Director County of Imperial	Date: <u>February 14, 2024</u>
Addendum No. 04 Acknowledge	ment
Each bidder must acknowledge recei	any and all subcontractors and suppliers of this addendum ipt of this addendum in the noted space below and where of the addendum is to be signed by the Bidder and submitted
Print or Type Bidder's Name:	
Print or Type Authorized Name:	
Authorized Signature of Bidder:	
Date Signed:	

SHEET INDEX TITLE SHEET HIGHWAY 111 - SANITARY SEWER PIPELINE AND MANHOLE IMPROVEMENT PLAN - STA 346+10 TO STA 375+62. **HIGHWAY 111 AND ALCOTT ROAD SANITARY SEWER** PIPELINE PLAN AND PROFILE - STA 346+10 TO STA 349+35. HIGHWAY 111 AND NOFFSINGER ROAD SANITARY SEWER PLAN AND PROFILE - STA 372+18 TO STA 375+20. SANITARY SEWER SECTIONS AND DETAILS TRAFFIC CONTROL PLAN TRAFFIC CONTROL PLAN WATER POLLUTION CONTROL PROGRAM

CONCEDITORIONI OVADOLO

CONSTRUCTION SYMBOLS		
	LEGEND	
ITEM NO.	DESCRIPTION	SYMBOL
1	EXISTING A.C. PAVEMENT	
2	PIPE TRENCH IN PAVEMENT AREAS	
3	TRENCH IN NATIVE AREAS	
4	P.C.C. STRUCTURES	
5	SIGNS / POSTS	-
6	POWER POLE	
7	GUY WIRE	——————————————————————————————————————
8	STREET LIGHT	\$
9	FOUND MONUMENT	M
10	TELEPHONE (AT&T) ENCLOSURE	1
11	WATER VALVE	•
12	WATER METER	W
13	FIRE HYDRANT	+0+
14	EXISTING TREE	
15	EXISTING PALM TREE	\$
16	RIGHT OF WAY	
17	LIMITS OF CONSTRUCTION	
18	SANITARY MANHOLE	S
19	WATER PIPELINE	w
20	GAS PIPELINE	——G ——
21	SANITARY SEWER PIPELINE	ss
22	CENTER LINE	—— © ——
23	STORM DRAIN MANHOLE	(SD)
24	MASONRY WALL	
25	EXISTING FENCE	* *
26	SANITARY SEWER CLEANOUT	(co)
27	AERIAL TARGET	Ā
28	BENCHMARK	•
20	COLD BLANE/A C. BAVEMENT MILLING AREA	T

COLD PLANE/A.C. PAVEMENT MILLING AREA

EDGE OF PAVEMENT


STATE OF CALIFORNIA

DEPARTMENT OF TRANSPORTATION

PROJECT PLANS FOR CONSTRUCTION ON STATE ROUTE

IN IMPERIAL COUNTY ON SR 111 **COUNTY OF IMPERIAL - NILAND WASTE WATER TREATMENT** PLANT AND COLLECTION SYSTEM IMPROVEMENTS

VICINITY MAP

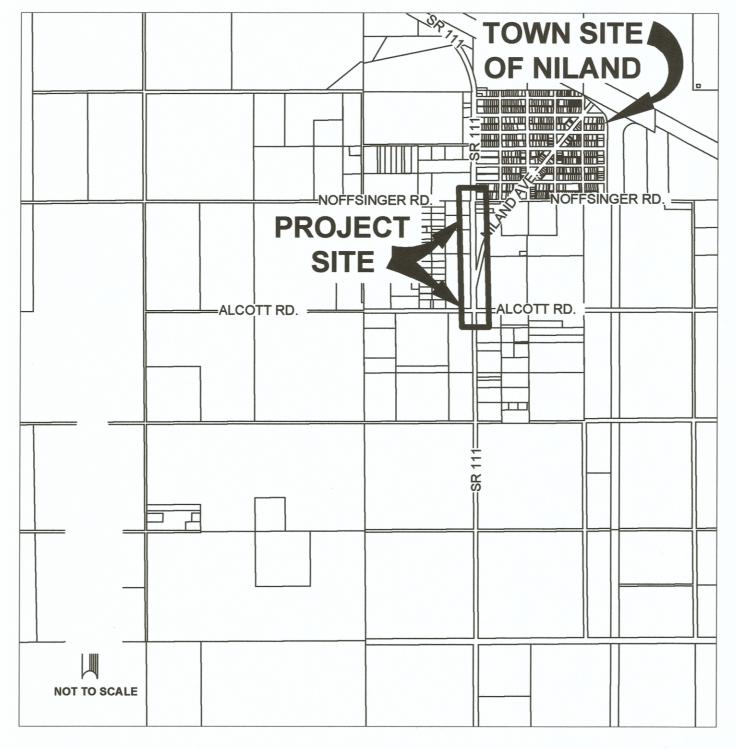

DATE SHEET NO. TOTAL ROUTE MILE POST COUNTY **TOTAL PROJECT** SHEETS **IMPERIAL** PM R39.589 & R40.089 SAN BERNARDINO

LOCATION MAP

ADDENDUM #4






RTE <u>111</u> PM R39.589 - R40.089

AS-BUILT PLANS FOR ROADWAY GEOMETRIC

STATE REPRESENTATIVE

LOCATION

PLANS APPROVAL DATE

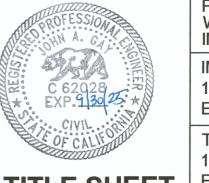

TITLE SHEET

NTS

PROJECT: COUNTY OF IMPERIAL - NILAND WASTE WATER TREATMENT PLANT AND COLLECTION SYSTEM IMPROVEMENTS. IMPERIAL COUNTY PUBLIC WORKS 155 S 11TH ST EL CENTRO, CA 92243 THE HOLT GROUP, INC. 1601 NORTH IMPERIAL AVENUE EL CENTRO, CA 92243 CONTRACT NO.

Know what's below.

Call before you dig.

ABBREVIATIONS

ASPHALT CONCRETE

BEGINNING OF CURVE RADIUS

CHIEF BUILDING OFFICIAL

AGGREGATE APPROXIMATE

BUILDING

CLEANOUT

DIAMETER

DRIVEWAY

ELEVATION

FLOWLINE

IRRIGATION LENGTH **MAXIMUM**

MINIMUM

NORTH

DELTA

DOUBLE CLEANOUT

EDGE OF PAVEMENT EAST / ELECTRICAL

END OF CURVE RADIUS FINISH FLOOR ELEVATION

FIRE PROTECTION

FINISH SURFACE

MISCELLANEOUS

NATIVE SURFACE NOT TO SCALE

OVERHEAD ELECTRICAL LINE

ON CENTER

PERCENT

PAD ELEVATION

POWER POLE

RADIUS/ RIGHT

RIGHT-OF-WAY SOUTH / SLOPE

POINT OF CONNECTION

POLY VINYL CHLORIDE

RESIDENT ENGINEER

REINFORCED CONCRETE PIPE

SANITARY SEWER / STAINLESS STEEL

SANITARY SEWER FORCE MAIN

TEMPORARY BENCHMARK

TOP OF PAVEMENT WEST / WATER

CENTERLINE **CLASS 2 BASE**

A.C.

BLDG.

CBO

CO

C2B

DIA.

DCO

D/W

E.P.

E.C.

F.S.

IRR

MAX. MIN.

MISC.

NS

N.T.S. O.C.

OHE P.E.

P.C.C.

POC

P.P.

P.V.C.

R.C.P.

R/W

SS

SSFM

TBM

T.C.

T.P.

11/11/

Underground Service Alert

Call: TOLL FREE 811

TWO WORKING DAYS BEFORE DIGGING

BENCH MARK

BRASS DISK LOCATED AT THE SOUTH WEST INTERSECTION OF ALCOTT ROAD AND STATE ROUTE 111. BRASS DISK LOCATED ALONG THE MOST SOUTHERN AND EASTERLY CORNER OF THE P.C.C. HEADWALL OF THE IMPERIAL IRRIGATION R LATERAL CANAL. EL 834.90

JOHN GAY, P.E.

DIRECTOR OF PUBLIC WORKS

DWG FILE=> C:\Users\fcastro.HOLT-LEGION-WIN\The Holt Group\542.089 - 542.089\04 - CAD & PDF DRAWINGS\10-18-2023- Set of Plans\CALTRANS 2024\542.089 - SHEET 1_Caltrans Title Sheet.dwg


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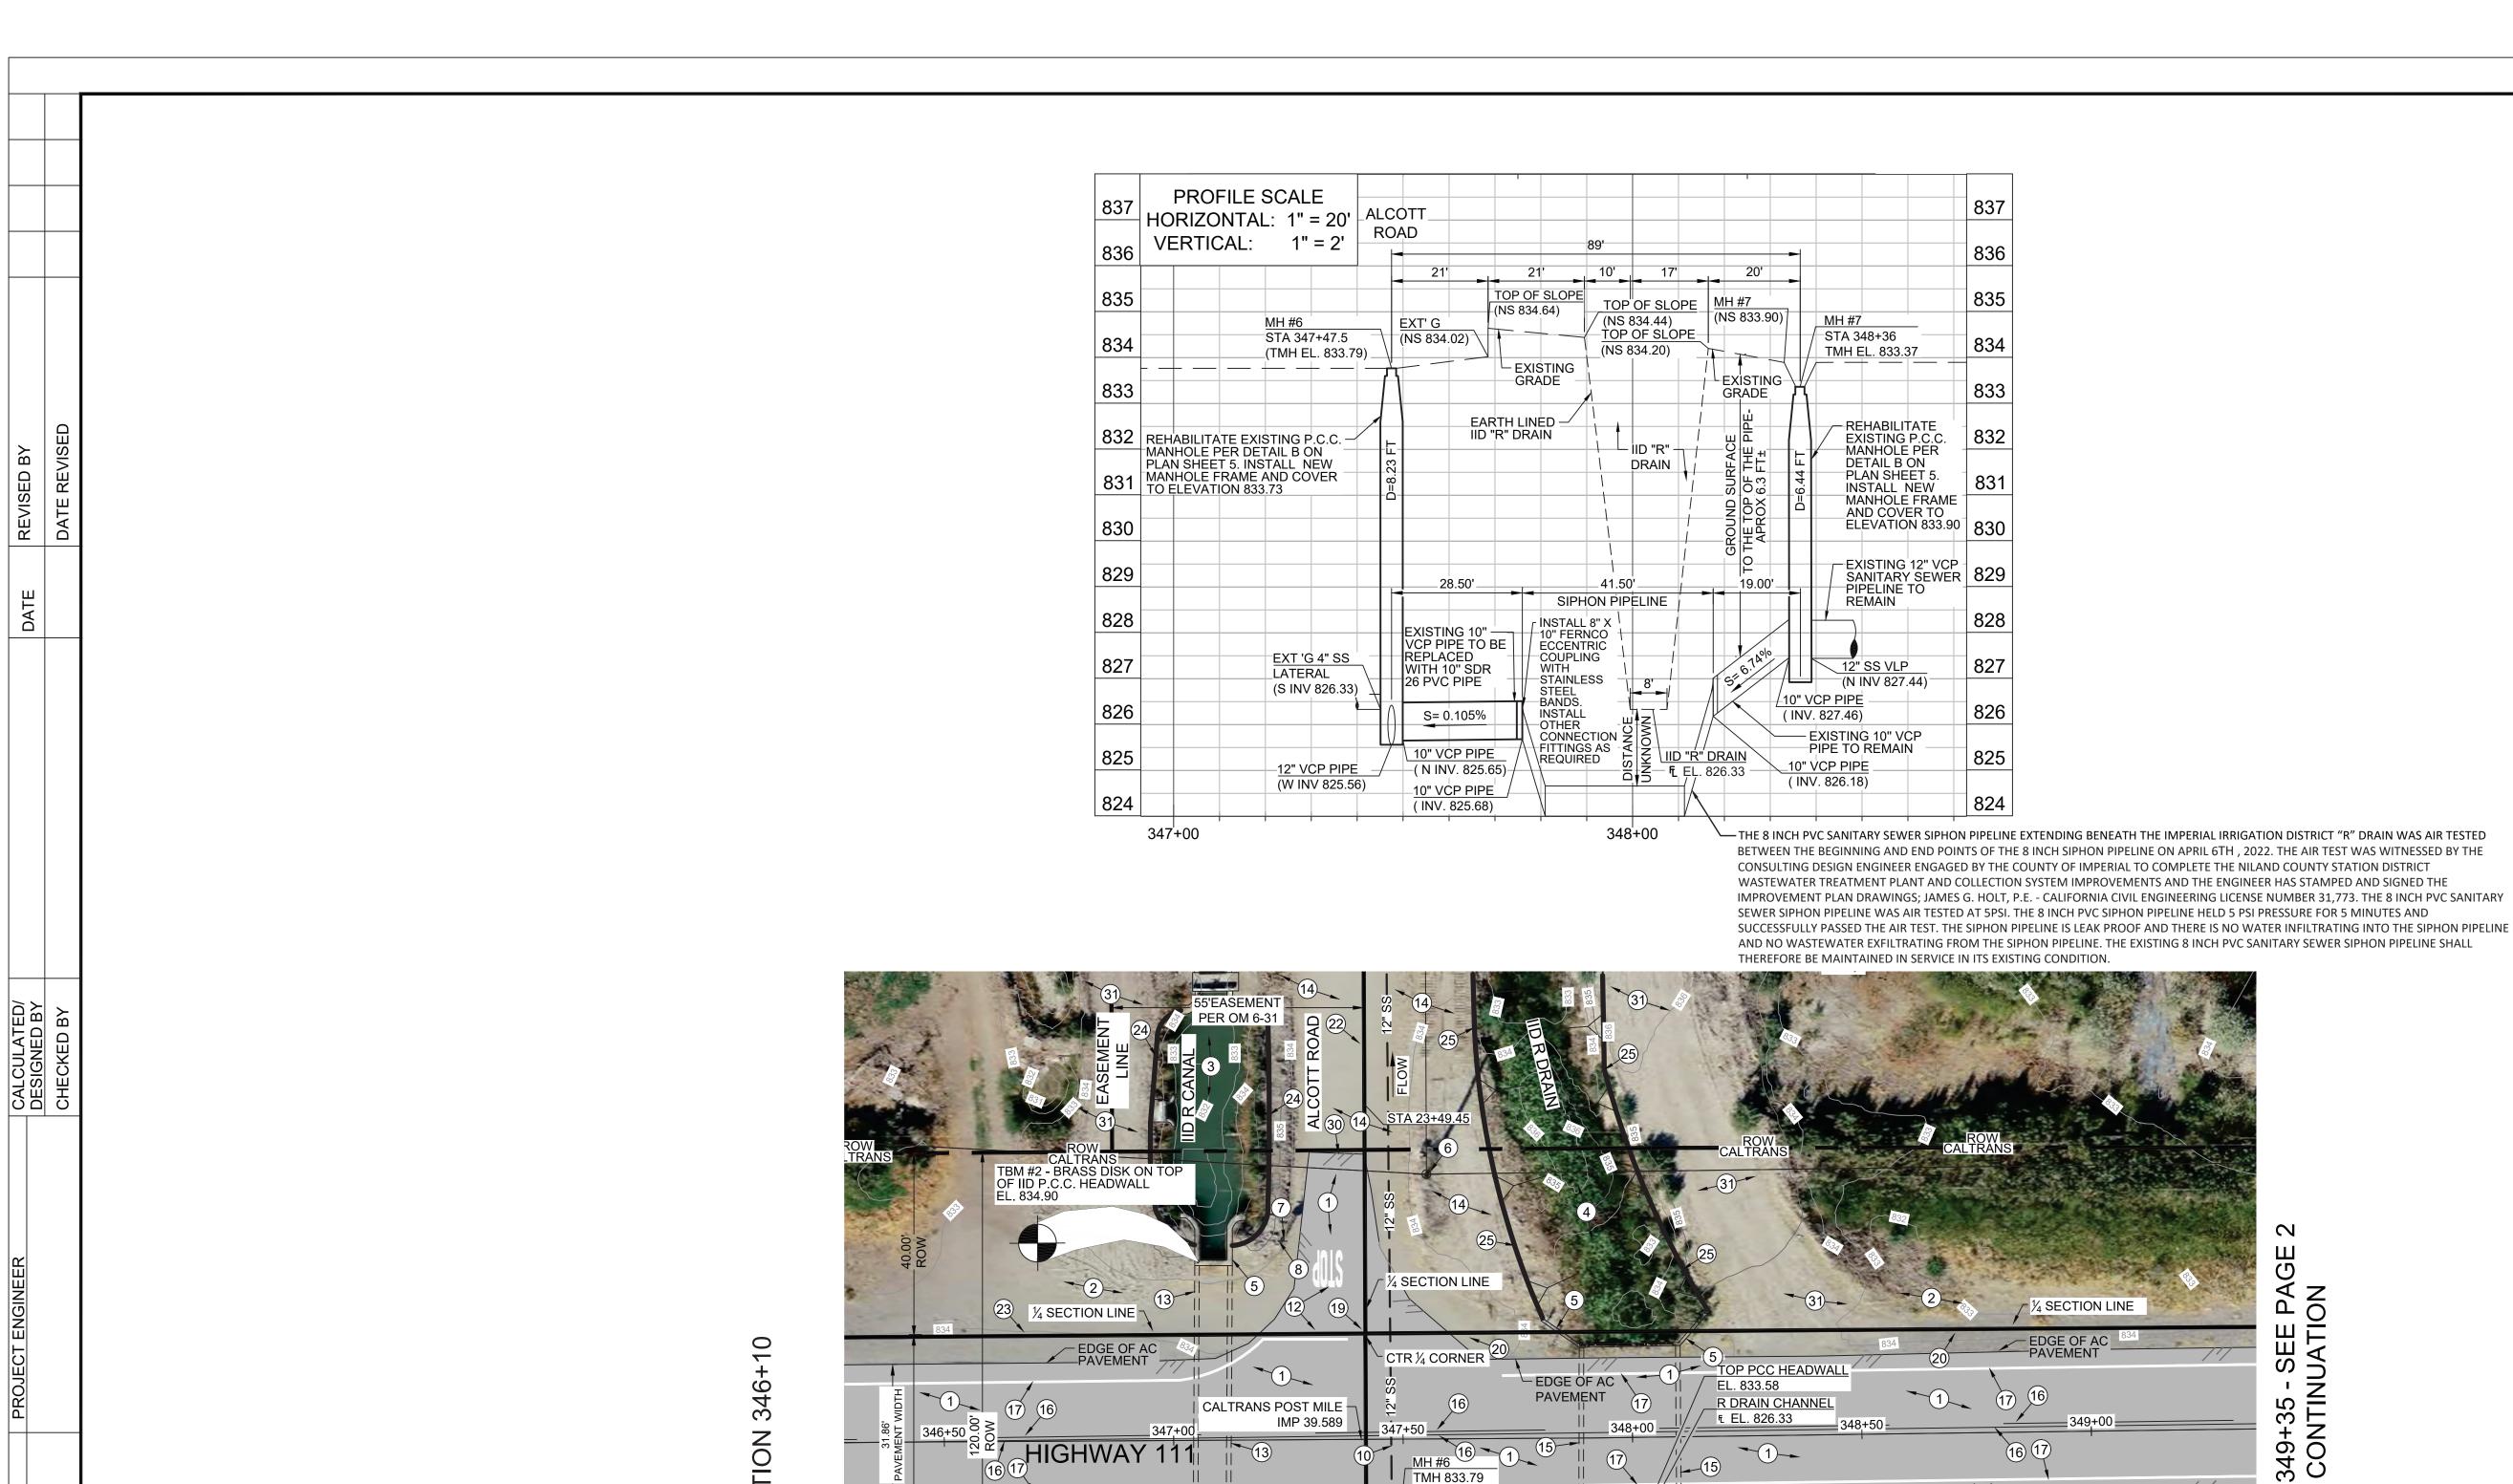
APPROVED FOR THE COUNTY OF IMPERIAL

62028

RCE NO.



PAGE 2-8

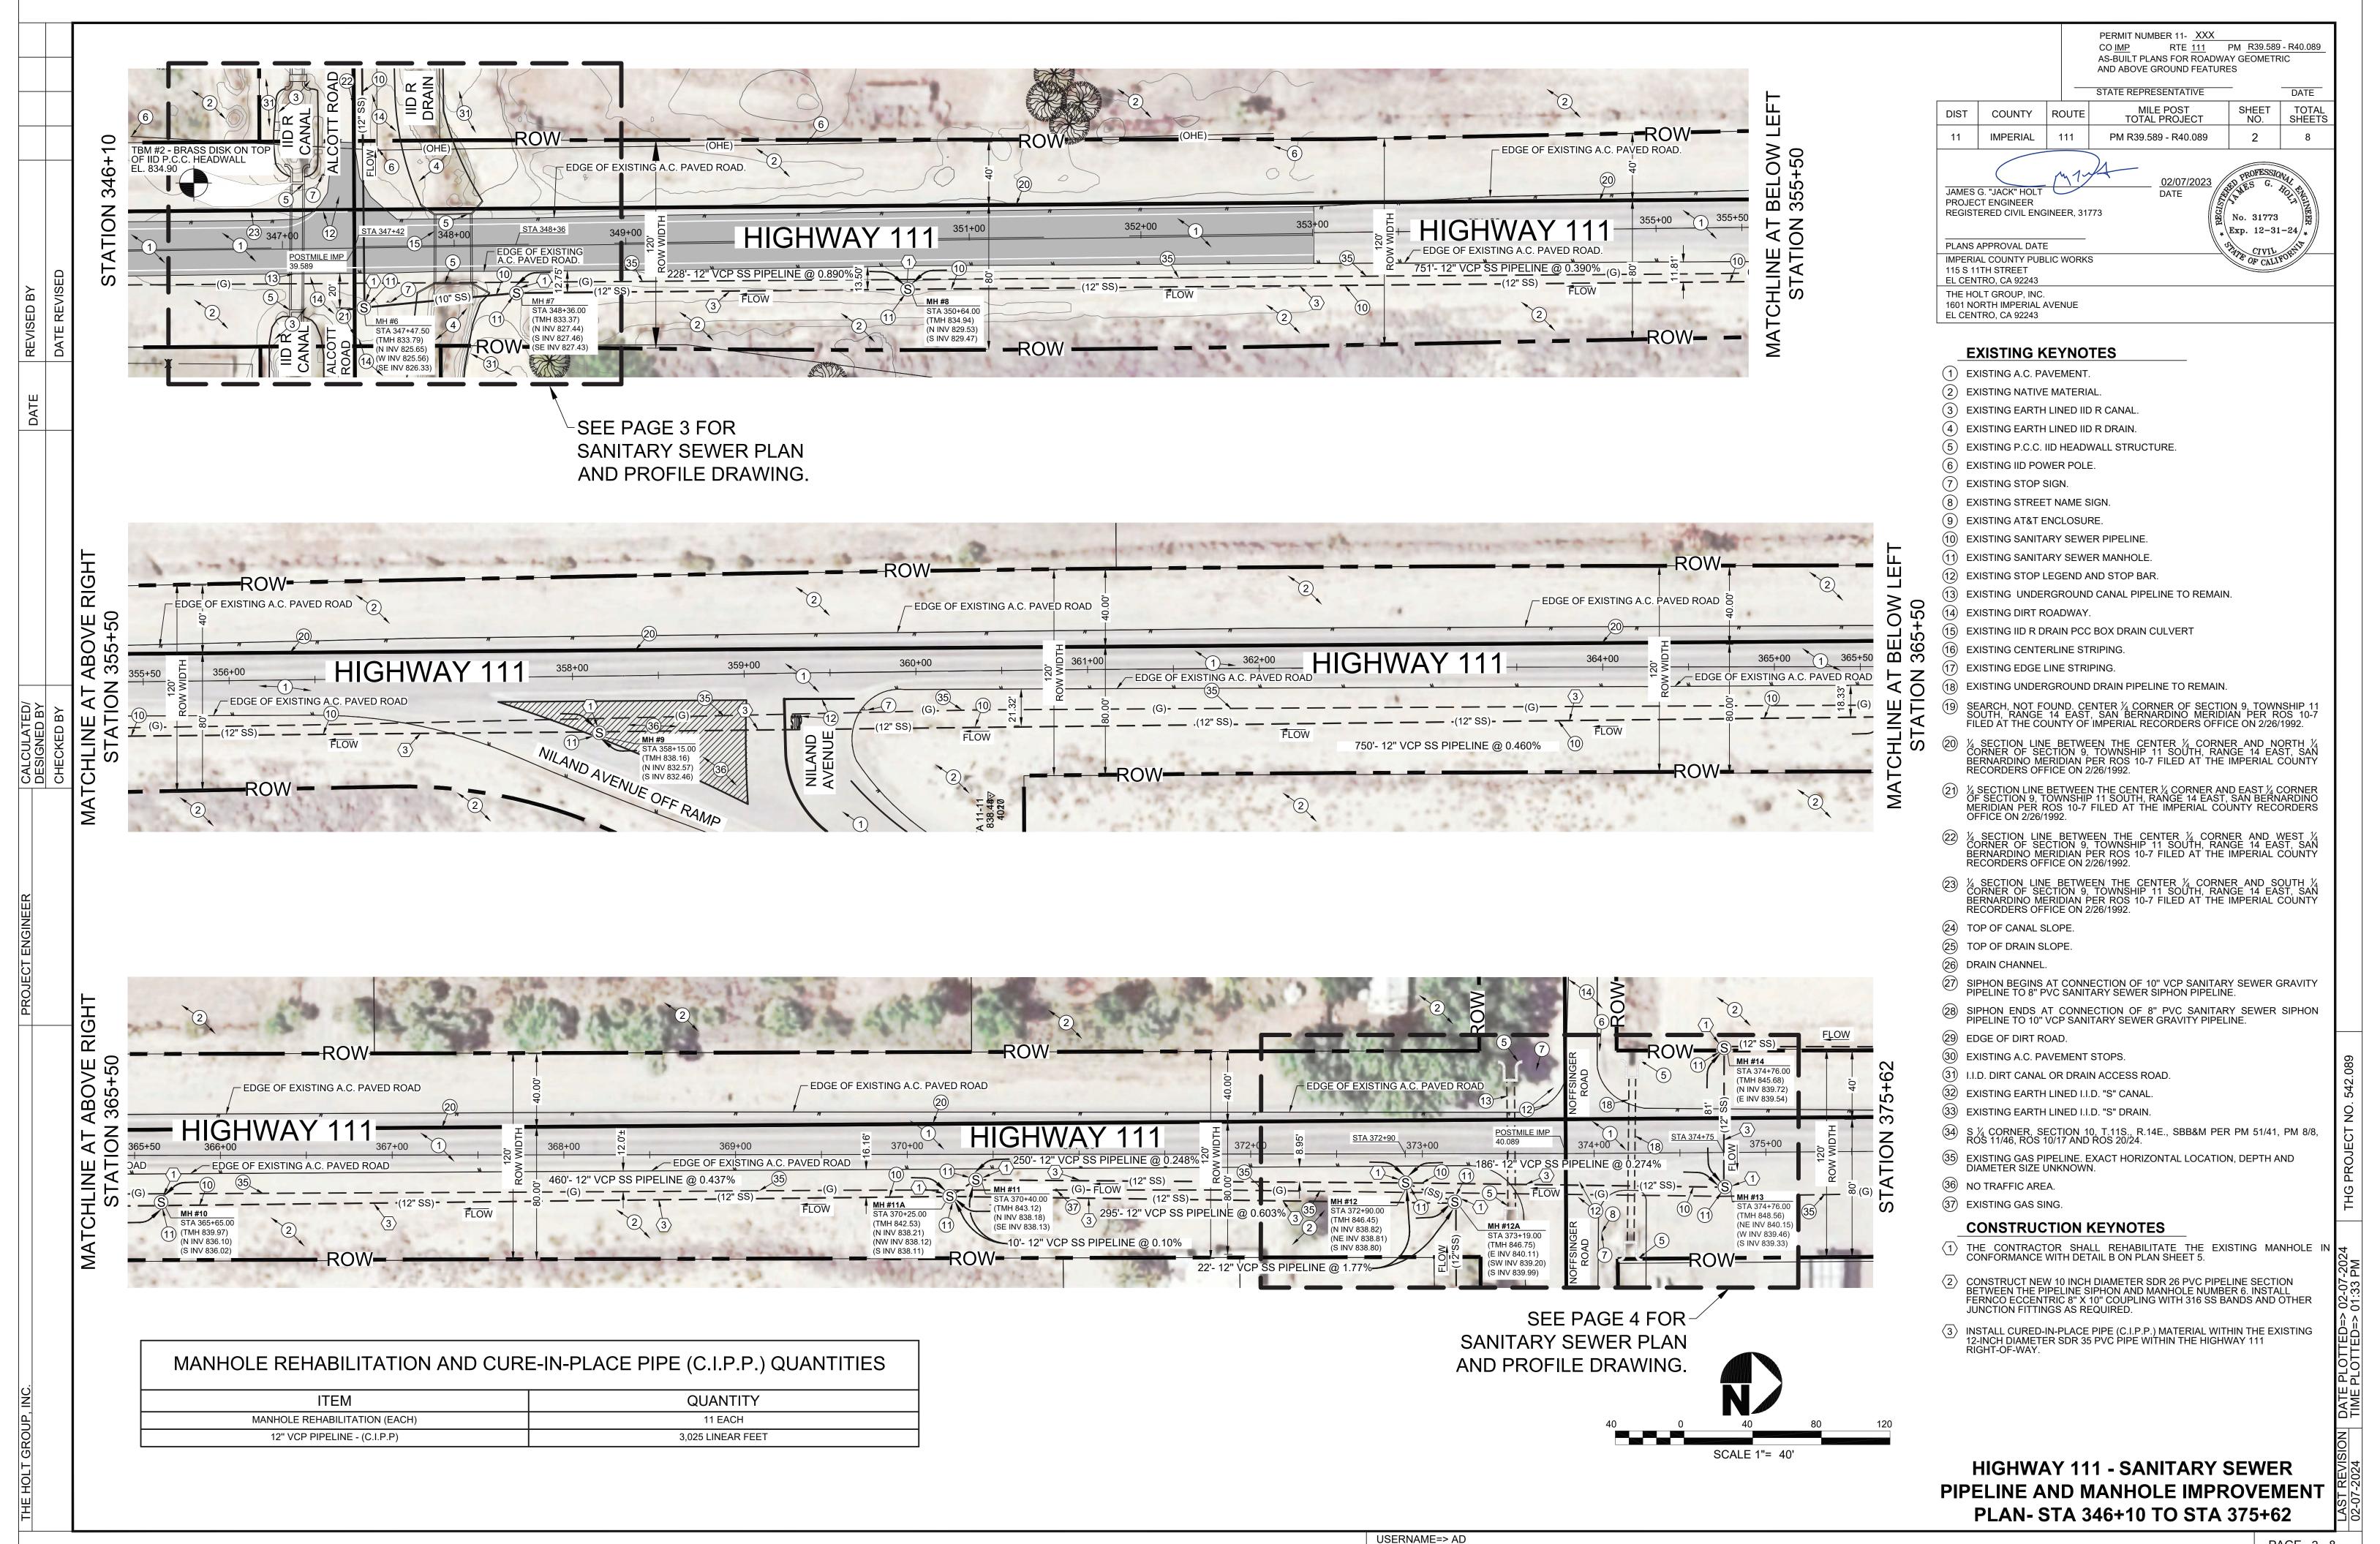

(D 349+35 - SEE CONTINUATION ON OR

SCALE 1"= 20'

AS-BUILT PLANS FOR ROADWAY GEOMETRIC AND ABOVE GROUND FEATURES STATE REPRESENTATIVE DATE SHEET NO. MILE POST TOTAL DIST COUNTY ROUTE TOTAL PROJECT **IMPERIAL** PM R39.589 - R40.089 JAMES G. "JACK" HOLT PROJECT ENGINEER REGISTERED CIVIL ENGINEER, 31773 No. 31773 $_{*}$ \Exp. 12-31-24/, PLANS APPROVAL DATE IMPERIAL COUNTY PUBLIC WORKS 115 S 11TH STREET EL CENTRO, CA 92243 THE HOLT GROUP, INC. 1601 NORTH IMPERIAL AVENUE EL CENTRO, CA 92243

PERMIT NUMBER 11- XXX

RTE 111 PM R39.589 - R40.089

EXISTING KEYNOTES

- (1) EXISTING A.C. PAVEMENT.
- (2) EXISTING NATIVE MATERIAL.
- (3) EXISTING EARTH LINED IID R CANAL.
- (4) EXISTING EARTH LINED IID R DRAIN.
- (5) EXISTING P.C.C. IID HEADWALL STRUCTURE.
- (6) EXISTING IID POWER POLE.
- (7) EXISTING STOP SIGN.
- (8) EXISTING STREET NAME SIGN.
- (9) EXISTING AT&T ENCLOSURE.
- (10) EXISTING SANITARY SEWER PIPELINE.
- (11) EXISTING SANITARY SEWER MANHOLE.
- (12) EXISTING STOP LEGEND AND STOP BAR.
- (13) EXISTING UNDERGROUND CANAL PIPELINE TO REMAIN.
- (14) EXISTING DIRT ROADWAY.
- (15) EXISTING IID R DRAIN PCC BOX DRAIN CULVERT
- (16) EXISTING CENTERLINE STRIPING.
- (17) EXISTING EDGE LINE STRIPING.
- (18) EXISTING UNDERGROUND DRAIN PIPELINE TO REMAIN.
- (19) SEARCH, NOT FOUND. CENTER ¼ CORNER OF SECTION 9, TOWNSHIP 11 SOUTH, RANGE 14 EAST, SAN BERNARDINO MERIDIAN PER ROS 10-7 FILED AT THE COUNTY OF IMPERIAL RECORDERS OFFICE ON 2/26/1992.
- 1/4 SECTION LINE BETWEEN THE CENTER 1/4 CORNER AND NORTH 1/4 CORNER OF SECTION 9, TOWNSHIP 11 SOUTH, RANGE 14 EAST, SAN BERNARDINO MERIDIAN PER 1808 10-7 FILED AT THE IMPERIAL COUNTY RECORDERS OFFICE ON 2/26/1992.
- MERIDIAN PER ROS 10-7 FILED AT THE IMPERIAL COUNTY RECORDERS OFFICE ON 2/26/1992.
- $\sp{1/4}$ SECTION LINE BETWEEN THE CENTER $\sp{1/4}$ CORNER AND WEST $\sp{1/4}$ CORNER OF SECTION 9, TOWNSHIP 11 SOUTH, RANGE 14 EAST, SAN BERNARDINO MERIDIAN PER ROS 10-7 FILED AT THE IMPERIAL COUNTY RECORDERS OFFICE ON 2/26/1992.
- 23 ½ SECTION LINE BETWEEN THE CENTER ½ CORNER AND SOUTH ½ CORNER OF SECTION 9, TOWNSHIP 11 SOUTH, RANGE 14 EAST, SAN BERNARDINO MERIDIAN PER ROSS 10-7 FILED AT THE IMPERIAL COUNTY RECORDERS OFFICE ON 2/26/1992.
- (24) TOP OF CANAL SLOPE.
- (25) TOP OF DRAIN SLOPE.
- (26) DRAIN CHANNEL.
- 27 SIPHON BEGINS AT CONNECTION OF 10" VCP SANITARY SEWER GRAVITY PIPELINE TO 8" PVC SANITARY SEWER SIPHON PIPELINE.
- SIPHON ENDS AT CONNECTION OF 8" PVC SANITARY SEWER SIPHON PIPELINE TO 10" VCP SANITARY SEWER GRAVITY PIPELINE.
- (29) EDGE OF DIRT ROAD.
- (30) EXISTING A.C. PAVEMENT STOPS.
- (31) I.I.D. DIRT CANAL OR DRAIN ACCESS ROAD.
- (32) EXISTING EARTH LINED I.I.D. "S" CANAL
- (33) EXISTING EARTH LINED I.I.D. "S" DRAIN.
- 34 S 1/4 CORNER, SECTION 10, T.11S., R.14E., SBB&M PER PM 51/41, PM 8/8, ROS 11/46, ROS 10/17 AND ROS 20/24.
- EXISTING GAS PIPELINE. EXACT HORIZONTAL LOCATION, DEPTH AND DIAMETER SIZE UNKNOWN.
- (36) NO TRAFFIC AREA.
- (37) EXISTING GAS SING.

CONSTRUCTION KEYNOTES

- THE CONTRACTOR SHALL REHABILITATE THE EXISTING MANHOLE IN CONFORMANCE WITH DETAIL B ON PLAN SHEET 5.
- (2) CONSTRUCT NEW 10 INCH DIAMETER SDR 26 PVC PIPELINE SECTION BETWEEN THE PIPELINE SIPHON AND MANHOLE NUMBER 6. INSTALL FERNCO ECCENTRIC 8" X 10" COUPLING WITH 316 SS BANDS AND OTHER JUNCTION FITTINGS AS REQUIRED.
- 3 INSTALL CURED-IN-PLACE PIPE (C.I.P.P.) MATERIAL WITHIN THE EXISTING 12-INCH DIAMETER SDR 35 PVC PIPE WITHIN THE HIGHWAY 111

HIGHWAY 111 AND ALCOTT ROAD SANITARY SEWER PIPELINE AND MANHOLE IMPROVEMENT PLAN- STA 346+10 TO STA 349+35


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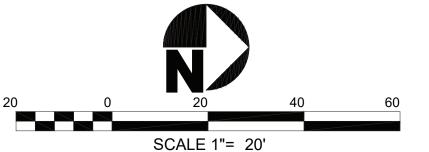
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 $lak{1}{4}$ SECTION LINE

EDGE OF AC PAVEMENT

REVISED BY



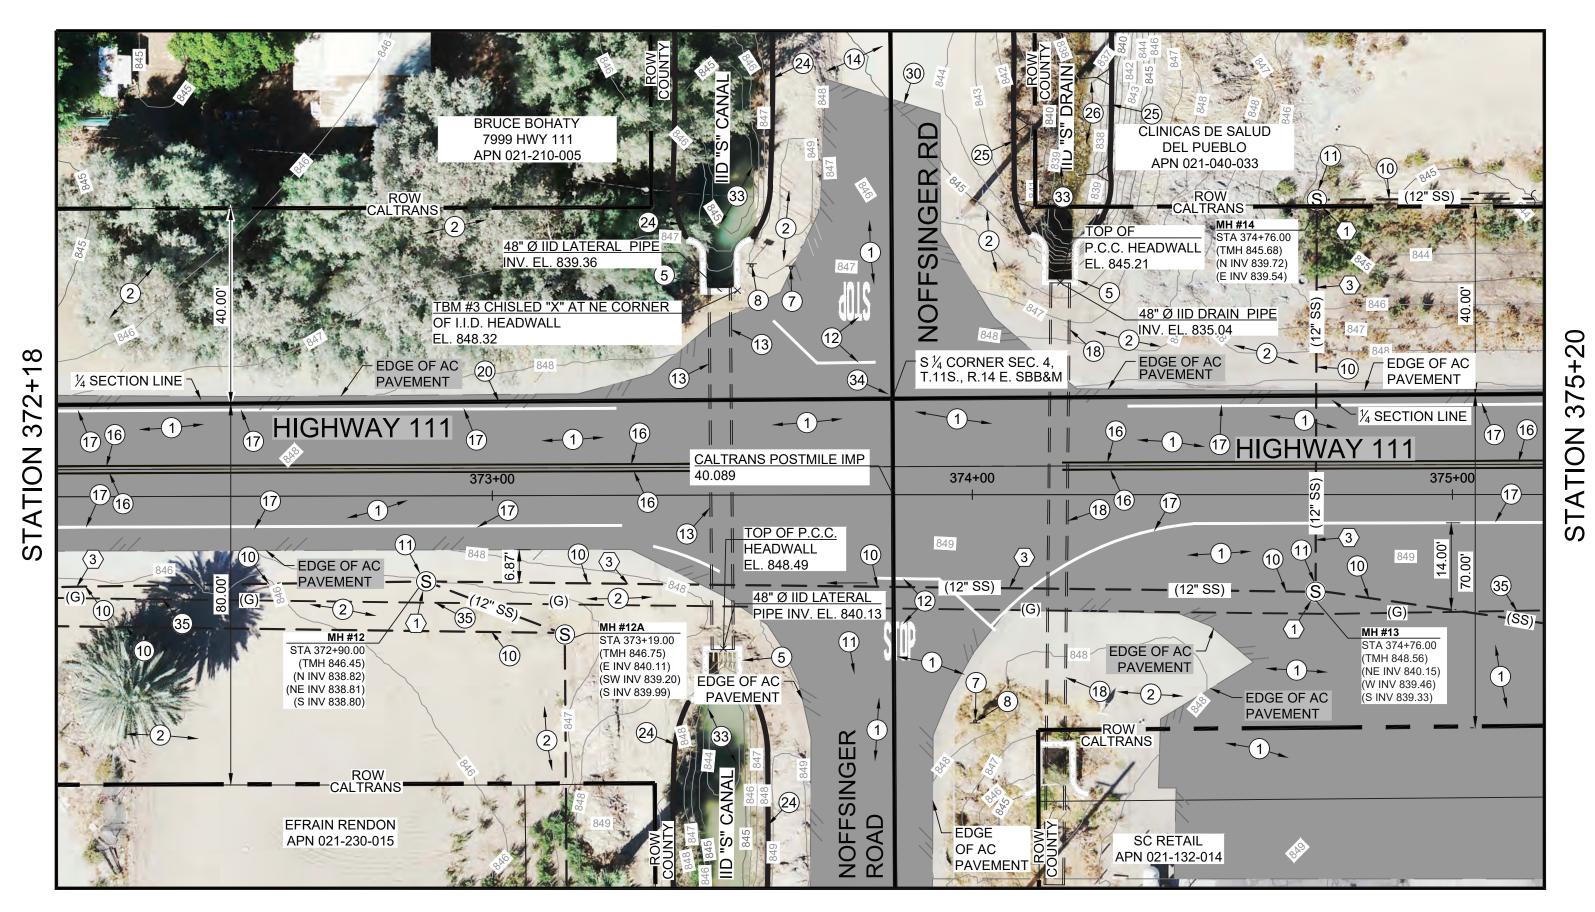

RTE <u>111</u> PM R39.589 - R40.089 AS-BUILT PLANS FOR ROADWAY GEOMETRIC AND ABOVE GROUND FEATURES STATE REPRESENTATIVE SHEET NO. TOTAL MILE POST DIST COUNTY ROUTE TOTAL PROJECT **IMPERIAL** PM R39.589 - R40.089 JAMES G. "JACK" HOLT PROJECT ENGINEER REGISTERED CIVIL ENGINEER, 31773 No. 31773 $_{*}$ \Exp. 12-31-24/, PLANS APPROVAL DATE IMPERIAL COUNTY PUBLIC WORKS 115 S 11TH STREET EL CENTRO, CA 92243 THE HOLT GROUP, INC. 1601 NORTH IMPERIAL AVENUE EL CENTRO, CA 92243

PERMIT NUMBER 11- XXX


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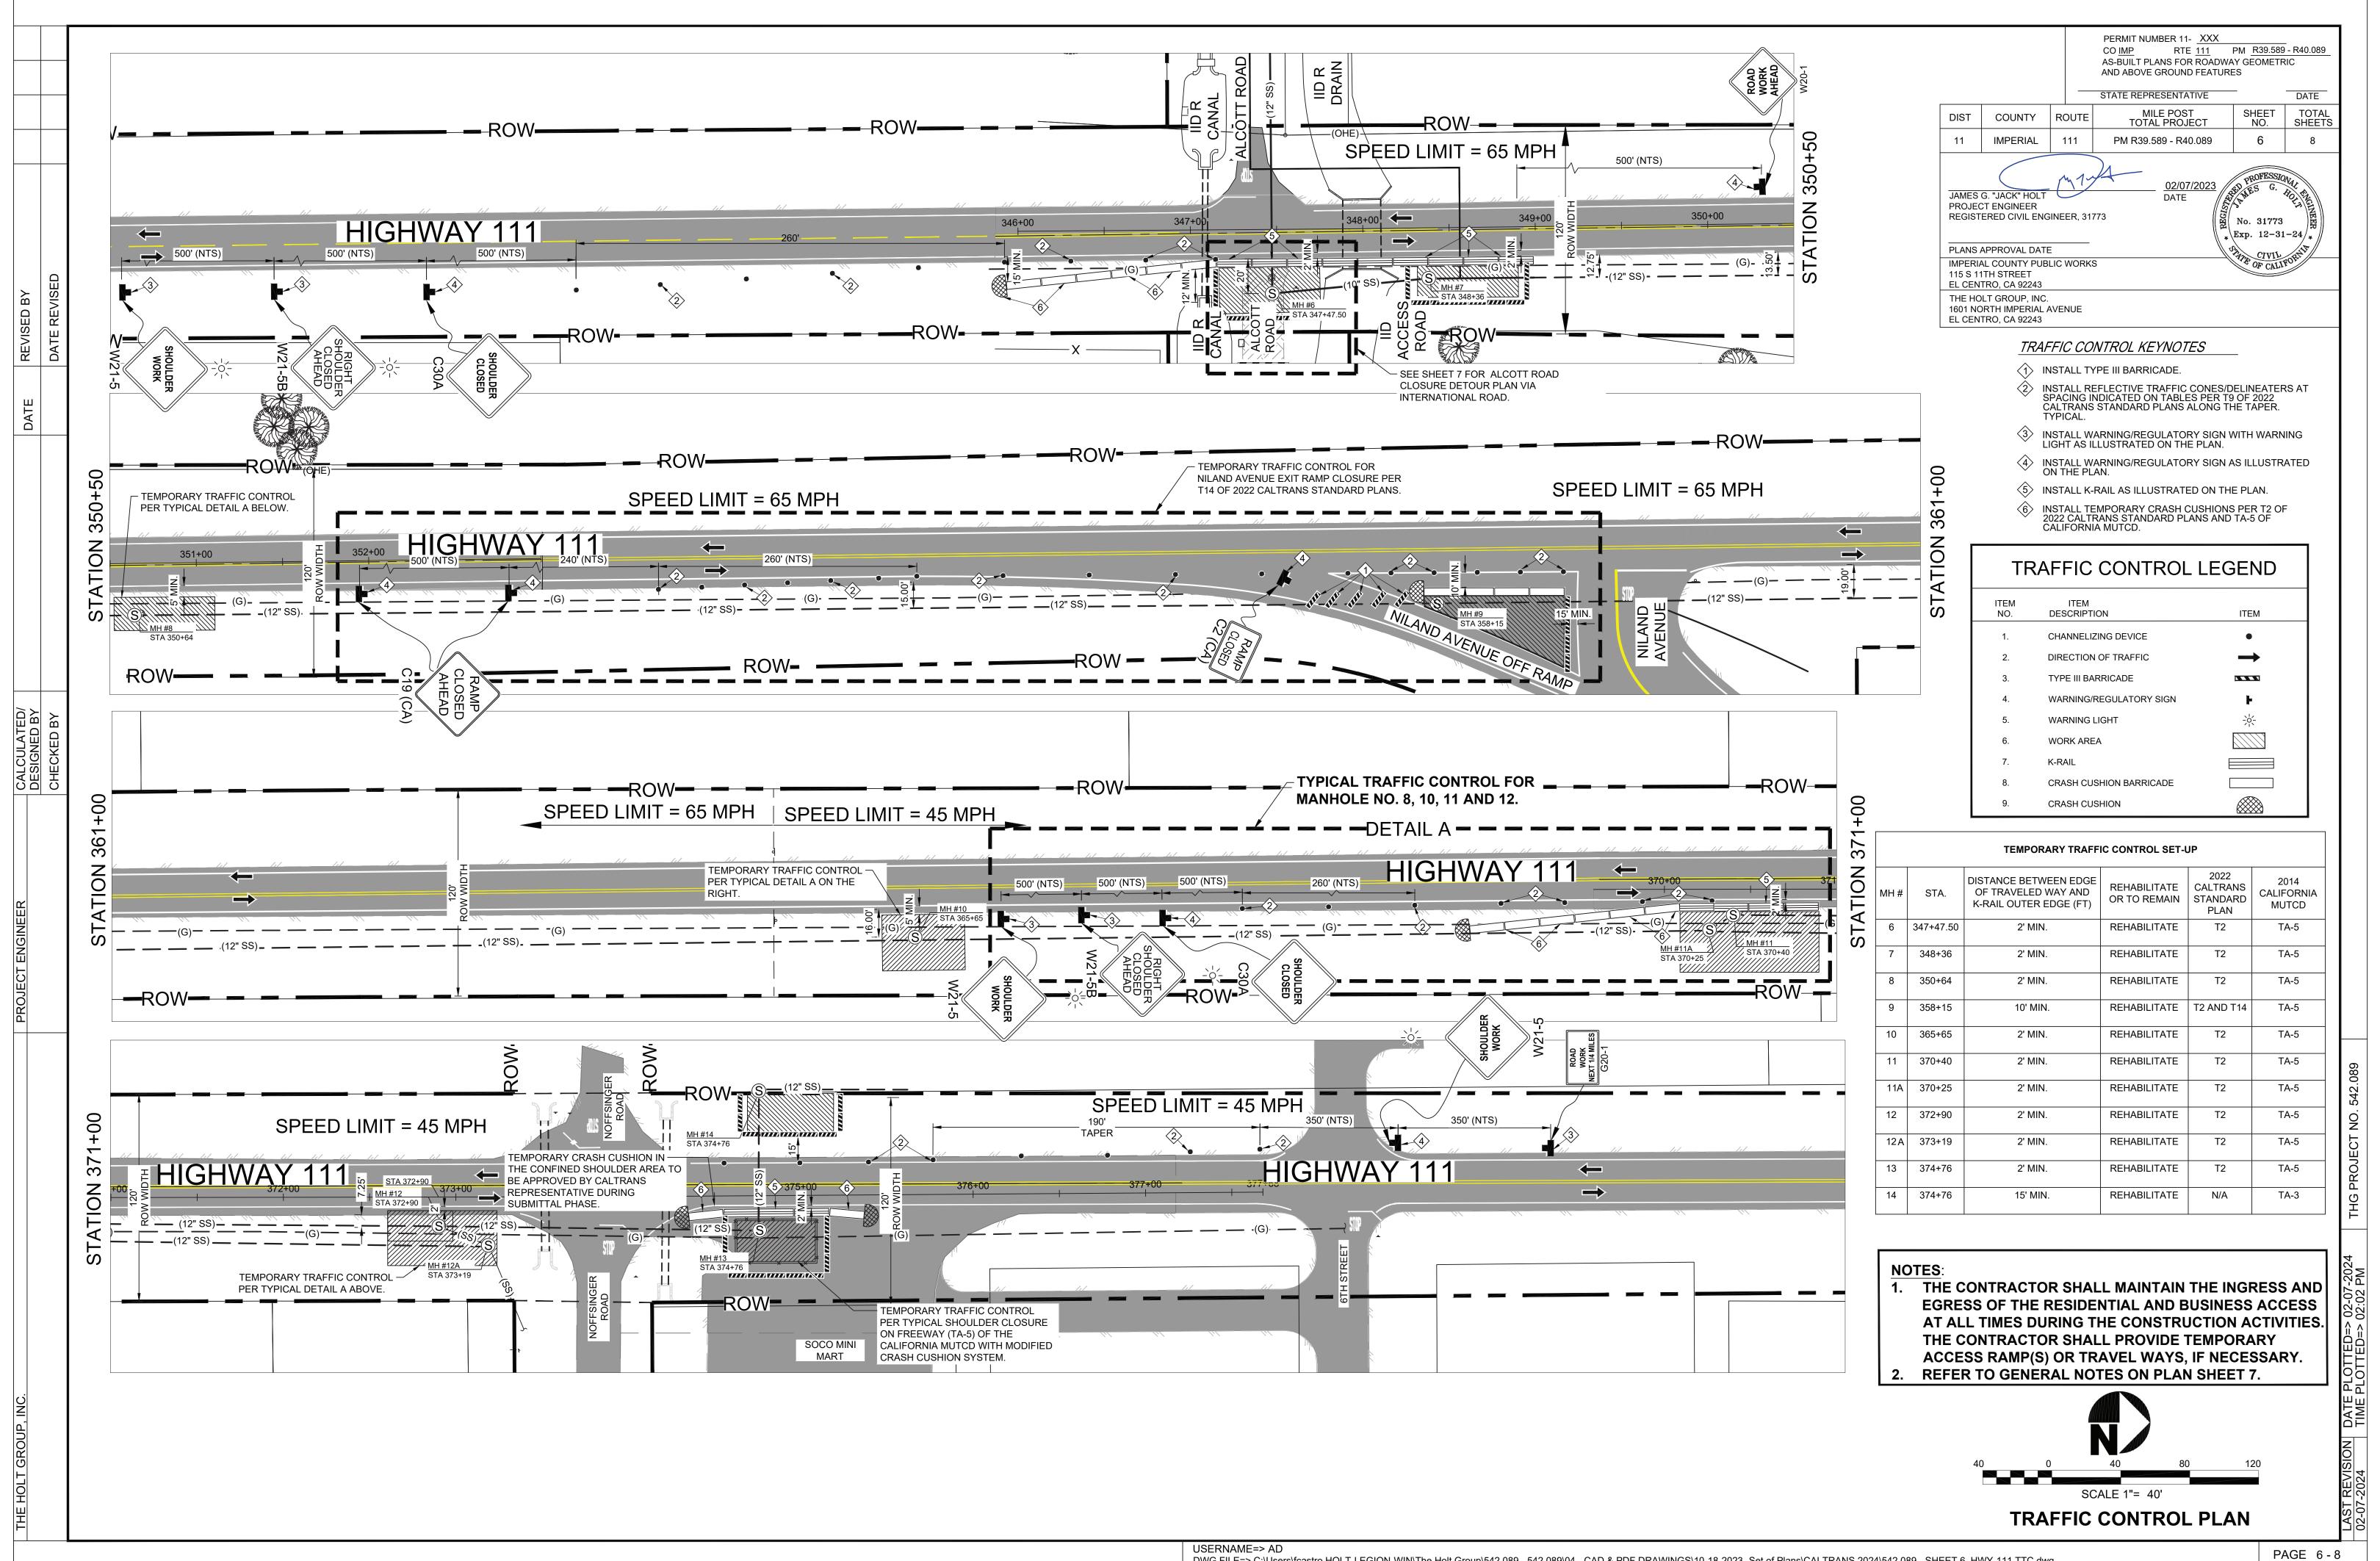
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- (16) EXISTING CENTERLINE STRIPING.
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- 20 ½ SECTION LINE BETWEEN THE CENTER ¼ CORNER AND NORTH ¼ CORNER OF SECTION 9, TOWNSHIP 11 SOUTH, RANGE 14 EAST, SAN BERNARDINO MERIDIAN PER ROS 10-7 FILED AT THE IMPERIAL COUNTY RECORDERS OFFICE ON 2/26/1992.
- 21 ½ SECTION LINE BETWEEN THE CENTER ½ CORNER AND EAST ½ CORNER OF SECTION 9, TOWNSHIP 11 SOUTH, RANGE 14 EAST, SAN BERNARDINO MERIDIAN PER ROS 10-7 FILED AT THE IMPERIAL COUNTY RECORDERS OFFICE ON 2/26/1992.
- 22) ¼ SECTION LINE BETWEEN THE CENTER ¼ CORNER AND WEST ¼ CORNER OF SECTION 9, TOWNSHIP 11 SOUTH, RANGE 14 EAST, SAN BERNARDINO MERIDIAN PER ROS 10-7 FILED AT THE IMPERIAL COUNTY RECORDERS OFFICE ON 2/26/1992.
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- (25) TOP OF DRAIN SLOPE.
- 26) DRAIN CHANNEL.
- SIPHON BEGINS AT CONNECTION OF 10" VCP SANITARY SEWER GRAVITY PIPELINE TO 8" PVC SANITARY SEWER SIPHON PIPELINE.
- SIPHON ENDS AT CONNECTION OF 8" PVC SANITARY SEWER SIPHON PIPELINE TO 10" VCP SANITARY SEWER GRAVITY PIPELINE.
- 29 EDGE OF DIRT ROAD.
- (30) EXISTING A.C. PAVEMENT STOPS.
- (31) I.I.D. DIRT CANAL OR DRAIN ACCESS ROAD.
- 32 EXISTING EARTH LINED I.I.D. "S" CANAL
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- 34) S ¼ CORNER, SECTION 10, T.11S., R.14E., SBB&M PER PM 51/41, PM 8/8, ROS 11/46, ROS 10/17 AND ROS 20/24.
- EXISTING GAS PIPELINE. EXACT HORIZONTAL LOCATION, DEPTH AND DIAMETER SIZE UNKNOWN.
- 36 NO TRAFFIC AREA.
- (37) EXISTING GAS SING.

CONSTRUCTION KEYNOTES

- 1 THE CONTRACTOR SHALL REHABILITATE THE EXISTING MANHOLE IN CONFORMANCE WITH DETAIL B ON PLAN SHEET 5.
- CONSTRUCT NEW 10 INCH DIAMETER SDR 26 PVC PIPELINE SECTION BETWEEN THE PIPELINE SIPHON AND MANHOLE NUMBER 6. INSTALL FERNCO ECCENTRIC 8" X 10" COUPLING WITH 316 SS BANDS AND OTHER JUNCTION FITTINGS AS REQUIRED.
- (3) INSTALL CURED-IN-PLACE PIPE (C.I.P.P.) MATERIAL WITHIN THE EXISTING 12-INCH DIAMETER SDR 35 PVC PIPE WITHIN THE HIGHWAY 111 RIGHT-OF-WAY.

HIGHWAY 111 AND NOFFSINGER ROAD SANITARY SEWER PIPELINE AND MANHOLE IMPROVEMENT PLAN- STA 372+18 TO STA 375+20 SION | DATE PI OTTED=> 02-07-2024 | _____



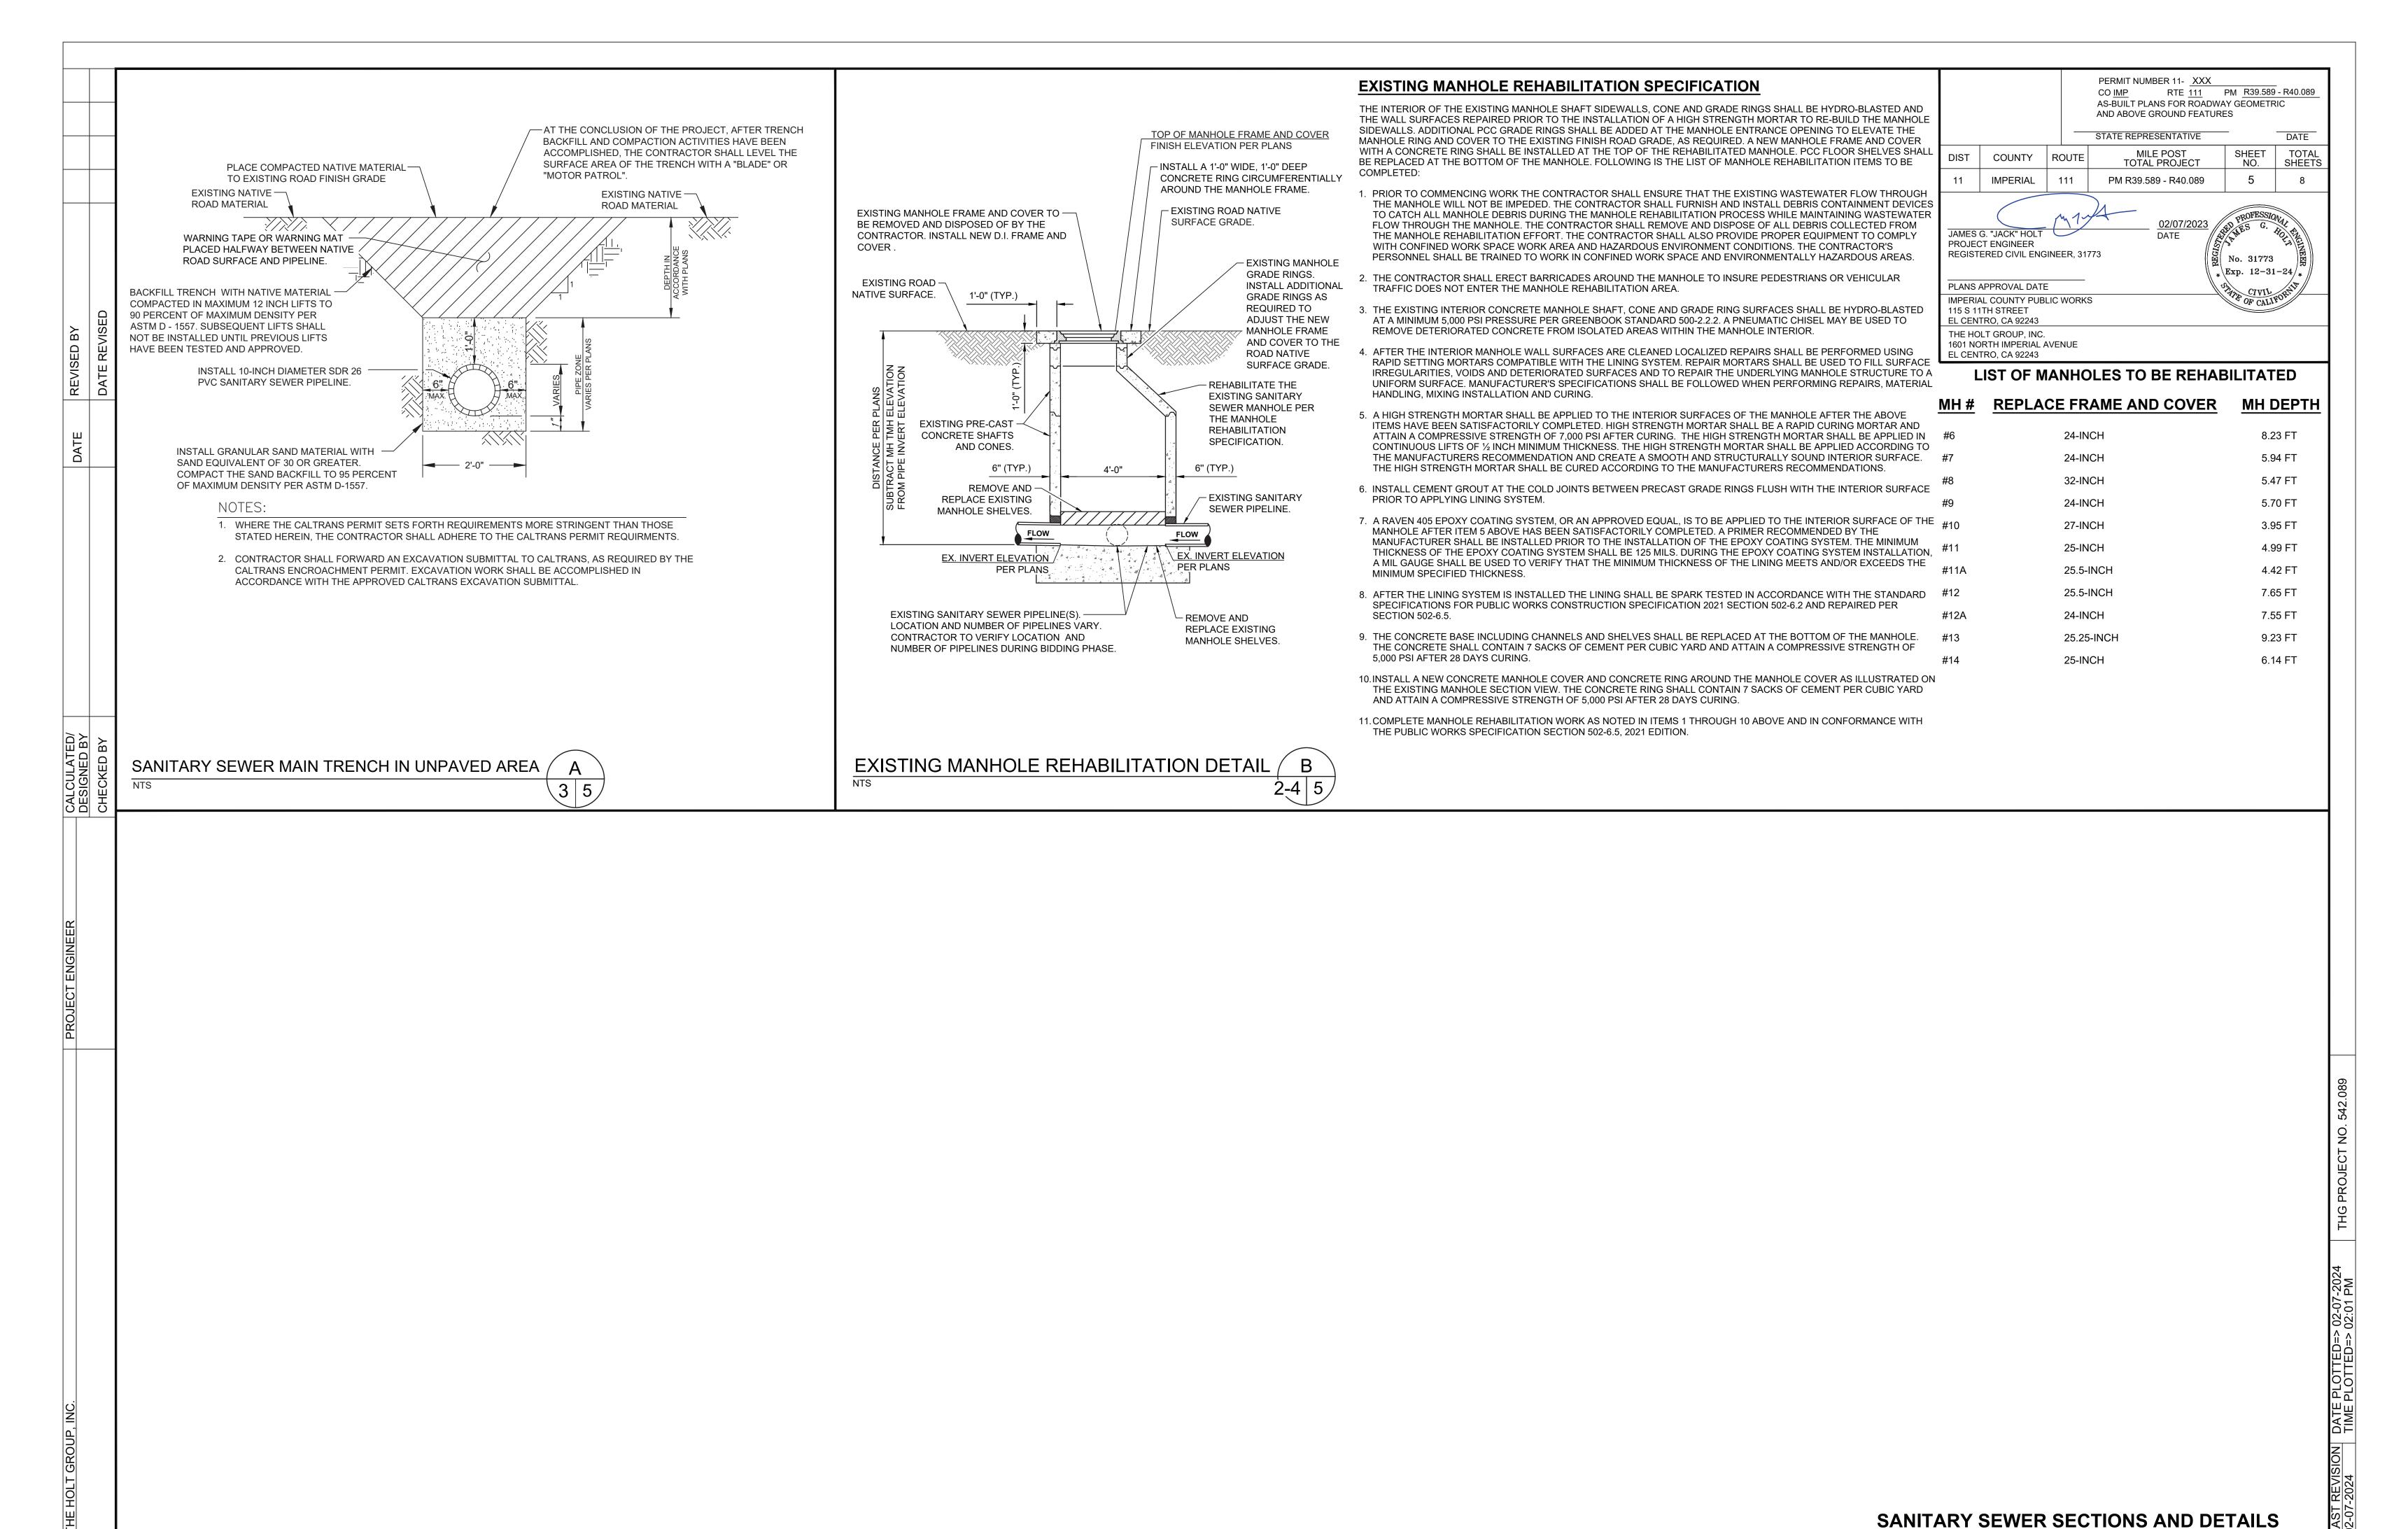

GENERAL TRAFFIC CONTROL NOTES:

ALL TRAFFIC CONTROL DEVICES FOR THIS PROJECT SHALL BE IN ACCORDANCE WITH THE LATEST REVISION OF CALTRANS STANDARD PLANS AND/OR MANUAL OF UNIFORM TRAFFIC CONTROL DEVICES (MUTCD) AND MUTCD CALIFORNIA SUPPLEMENT.

PLANS APPROVAL DATE

115 S 11TH STREET EL CENTRO, CA 92243 THE HOLT GROUP, INC.

EL CENTRO, CA 92243

IMPERIAL COUNTY PUBLIC WORKS

1601 NORTH IMPERIAL AVENUE

DIST

- TRAFFIC CONTROL SHOWN HEREIN IS THE MINIMUM REQUIRED. ADDITIONAL TRAFFIC CONTROL MAY BE REQUIRED TO FACILITATE PUBLIC SAFETY AND TRAFFIC FLOW IF DEEMED NECESSARY BY THE CALTRANS REPRESENTATIVE, COUNTY OF IMPERIAL PUBLIC WORKS DEPARTMENT REPRESENTATIVE, OR THE COUNTY ENGINEER. THESE CHANGES MAY BE DONE IN THE FIELD.
- TRAFFIC CONTROL DEVICES SHOWN ON PLANS ARE LOCATED APPROXIMATELY AND SHALL BE ADJUSTED AS REQUIRED TO MEET FIELD CONDITIONS. ALL SUCH CHANGES MADE DUE TO FIELD CONDITIONS SHALL BE IN ACCORDANCE WITH THE LATEST VERSION OF CALTRANS STANDARD PLANS, MUTCD, AND MUTCD CALIFORNIA SUPPLEMENT
- 4. THROUGHOUT EACH WORK PERIOD, CONTRACTOR SHALL INSPECT TRAFFIC CONTROL (SIGNS, BARRICADES AND DELINEATORS) AND MAINTAIN SAME IN ACCORDANCE WITH TRAFFIC CONTROL
- CONTRACTOR SHALL MAINTAIN A MINIMUM 12-FEET TRAFFIC LANE WIDTH AT ALL TIMES. THERE SHALL BE A MINIMUM 2-FEET BETWEEN THE EDGE OF CUT AND THE NEAREST TRAFFIC LANE.
- 6. ACCESS TO PRIVATE PROPERTY SHALL BE MAINTAINED AT ALL TIMES.
- ALL SIGNS SHALL BE HIGH INTENSITY REFLECTIVE. ALL TRAFFIC CONTROL DEVICES SHALL BE REFLECTIVE. FLASHING LIGHTS ARE OPTIONAL. TRAFFIC BEACONS (12") SHALL BE PLACED ON ALL DETOUR AHEAD (W21-4) AND ROAD CLOSED AHEAD (C19) SIGNS.
- THE INTENSITY AND DISTRIBUTION OF LIGHT FROM EACH ILLUMINATED SIGNAL LENS SHOULD CONFORM TO THE CURRENT "STANDARDS FOR VEHICLE TRAFFIC CONTROL SIGNAL HEADS" AND TRAFFIC SIGNAL LAMPS" (SEE SECTION 1A.11 OF LATEST VERSION OF CAMUTCD). IF A SIGNAL INDICATION IS OPERATED IN THE FLASHING MODE FOR NIGHTTIME OPERATION AND THE SIGNAL INDICATION IS SO BRIGHT AS TO CAUSE EXCESSIVE GLARE, SOME FORM OF AUTOMATIC DIMMING SHOULD BE USED TO REDUCE THE BRILLIANCE OF THE SIGNAL INDICATION.
- 9. REFER TO THE LATEST REVISION OF CALIFORNIA MUTCD REGARDING THE NOTES FOR EACH TYPICAL APPLICATION CALLED OUT ON THIS PLAN.
- 10. CONTRACTOR SHALL INSPECT TRAFFIC CONTROL AT THE BEGINNING AND AT THE END OF EACH WORKING DAY TO ENSURE COMPLIANCE WITH THESE PLANS AND PROJECT SPECIFICATIONS.
- 11. ALL TEMPORARY TRAFFIC CONTROL DEVICES NOT APPLICABLE FOR NIGHT TIME TEMPORARY TRAFFIC CONTROL SHALL BE REMOVED AND STORED AT A SAFE LOCATION. NO SUCH DEVICE SHALL BE LEFT IN PLACE WITHOUT PRIOR APPROVAL BY THE CALTRANS REPRESENTATIVE AND/OR COUNTY OF IMPERIAL PUBLIC WORKS DEPARTMENT REPRESENTATIVE AND/OR THE COUNTY
- ARROWS AND STRIPING IN CONSTRUCTION ZONE SHALL BE COVERED WITH TEMPORARY STRIPING BLACKOUT TAPE. THE TAPE SHALL BE REMOVED AT THE END OF THE WORK.
- 13. THE CALTRANS REPRESENTATIVE, COUNTY OF IMPERIAL PUBLIC WORKS DEPARTMENT REPRESENTATIVE AND/OR THE PROJECT RESIDENT ENGINEER SHALL DETERMINE IF THE PLAN STAYS IN PLACE OVERNIGHT OR NOT. IF A PORTION OF THE CONSTRUCTION AREA MUST REMAIN OPEN AT THE END OF EACH WORK DAY, EACH EXPOSED SECTION MUST BE COMPLETELY FILLED WITH CLASS 2 BASE MATERIAL AND SURROUNDED WITH BARRICADES AND TAPE OR AS APPROVED BY THE CALTRANS REPRESENTATIVE, COUNTY OF IMPERIAL PUBLIC WORKS DEPARTMENT REPRESENTATIVE OR THE COUNTY ENGINEER.
- 14. CONTRACTOR SHALL APPLY TEMPORARY TRAFFIC CONTROL IN ACCORDANCE WITH THE LATEST VERSION OF MUTCD, MUTCD CALIFORNIA SUPPLEMENT, AND CALTRANS STANDARD PLANS FOR THE INSTALLATION OF TEMPORARY STRIPING.
- 15. ALL ADJACENT BUSINESSES, RESIDENCES, SCHOOL AND CHURCHES SHALL BE DULY NOTIFIED BY THE CONTRACTOR, IN WRITING, OF THEIR PROPOSED OPERATIONS. NOTICE SHALL BE DELIVERED AT LEAST TWO (2) WORKING WEEKS PRIOR TO START OF CONSTRUCTION ACTIVITIES. THE CONTRACTOR SHALL BE RESPONSIBLE FOR REPRODUCTION OF NOTIFICATION LETTERS. THE NOTIFICATION LETTERS SHALL BE WRITTEN IN ENGLISH AND SPANISH LANGUAGES. RE-NOTIFICATION WILL BE REQUIRED IF THE CONTRACTOR'S SCHEDULE IS ALTERED OR OTHER DELAYS OCCUR WHICH AFFECT THE PROJECT SCHEDULE.
- 16. CONTRACTOR SHALL COVER EXISTING TRAFFIC SIGNS, TRAFFIC SIGNALS, OR PEDESTRIAN SIGNAL INDICATIONS SHOULD SAID CONTROLS CONFLICT WITH TEMPORARY TRAFFIC CONTROL PLAN OR AS DIRECTED BY THE CALTRANS OR COUNTY OF IMPERIAL REPRESENTATIVE.
- 17. CONTRACTOR SHALL REPLACE/REPAIR ANY AND ALL STRIPING, PAVEMENT MARKINGS, RAISED PAVEMENT MARKERS, AND CURB PAINT DISRUPTED OR REMOVED DURING THE CONSTRUCTION TO THE SATISFACTION OF THE CALTRANS REPRESENTATIVE AND/OR COUNTY ENGINEER. ALL CONFLICTING LINES, ARROWS, MARKINGS, OR CURB PAINT SHALL BE REMOVED BY WET SANDBLASTING OR OTHER APPROVED METHOD PRIOR TO INSTALLATION OF NEW/TEMPORARY STRIPING. ALL CONFLICTING RAISED PAVEMENT MARKERS SHALL BE REMOVED. PAVEMENT THAT IS DAMAGED DUE TO THE REMOVAL OF MARKINGS SHALL BE REPAIRED TO THE SATISFACTION OF THE CALTRANS REPRESENTATIVE AND/OR COUNTY ENGINEER.
- 18. WHENEVER THE WORK CAUSES OBLITERATION OF PAVEMENT DELINEATION, TEMPORARY OR PERMANENT PAVEMENT DELINEATION SHALL BE IN PLACE PRIOR TO OPENING THE TRAVELED WAY TO PUBLIC TRAFFIC. LANE LINES AND CENTERLINE PAVEMENT DELINEATION SHALL BE PROVIDED AT ALL TIMES FOR TRAVELED WAYS OPEN TO THE PUBLIC TRAFFIC
- 19. ALL ADVANCED WARNING SIGNS SHALL BE EQUIPPED WITH FLAGS FLASHING YELLOW BEACONS, TYPE-B ON ALL W20-1 SIGNS AND ON ALL TYPE-III AND TYPE-II BARRICADES GUARDING THE WORK

TRAFFIC CONTROL KEYNOTES

1 INSTALL TYPE III BARRICADE.

NOFFSINGER ROAD

/ DIRT ROAD

ALCOTT ROAD

DETOUR PLAN FOR ALCOTT ROAD CLOSURE

DETOUF

HIGHWAY

WORK


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- INSTALL REFLECTIVE TRAFFIC CONES/DELINEATERS AT SPACING INDICATED ON TABLES PER T9 OF 2022 CALTRANS STANDARD PLANS ALONG THE TAPER.
- (3) INSTALL WARNING/REGULATORY SIGN WITH WARNING LIGHT AS ILLUSTRATED ON THE PLAN.
- install warning/regulatory sign as illustrated on the plan.
- (5) INSTALL K-RAIL AS ILLUSTRATED ON THE PLAN.
- INSTALL TEMPORARY CRASH CUSHIONS PER T2 OF 2022 CALTRANS STANDARD PLANS AND TA-5 OF CALIFORNIA MUTCD.

TRAFFIC CONTROL LEGEND		
ITEM NO.	ITEM DESCRIPTION	ITEM
1.	CHANNELIZING DEVICE	•
2.	DIRECTION OF TRAFFIC	\rightarrow
3.	TYPE III BARRICADE	
4.	WARNING/REGULATORY SIGN	F .
5.	WARNING LIGHT	->-\-
6.	WORK AREA	
7.	K-RAIL	
8.	CRASH CUSHION BARRICADE	
9.	CRASH CUSHION	

NOTE: THE CONTRACTOR SHALL MAINTAIN THE INGRESS AND EGRESS OF THE RESIDENTIAL AND BUSINESS ACCESS AT ALL TIMES DURING THE CONSTRUCTION ACTIVITIES. THE CONTRACTOR SHALL PROVIDE TEMPORARY ACCESS RAMP(S) OR TRAVEL WAYS, IF NECESSARY.



M20-1

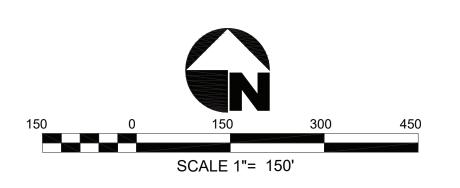WORK NORK

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